


- GENERAL NOTES:**
- SEE DRAWING C-1 FOR ADDITIONAL NOTES.
  - MAXIMUM FINAL SLOPE IS 3 HORIZONTAL TO 1 VERTICAL. MINIMUM FINAL SLOPE IS 14 HORIZONTAL TO 1 VERTICAL WITHIN LIMITS OF CAP.
  - CONTRACTOR SHALL REGRADE, EXCAVATE, AND/OR RELOCATE WASTE ONLY TO THE EXTENT NECESSARY TO ACHIEVE THE PREPARATORY GRADES AND CONTAIN WASTE WITHIN THE LIMIT OF CAPPING.
  - ALL EXCAVATED WASTE SHALL BE COVERED DAILY WITH 6 INCHES OF COMMON FILL. NO WASTE SHALL REMAIN EXPOSED OVERNIGHT.
  - FINAL GRADES SHALL BE BASED ON THE ESTABLISHED PREPARATORY GRADES AND THE FINAL COVER SYSTEM DETAILS.
  - PERMANENT EARTH DIVERSION DIKES SHALL BE INSTALLED IMMEDIATELY UPON REACHING FINISHED GRADES.
  - CONTRACTOR SHALL DISTURB ONLY THOSE AREAS DESIGNATED ON THE DRAWINGS OR REQUIRED TO PERFORM THE CONSTRUCTION.

- EROSION CONTROL AND SEDIMENTATION NOTES:**
- CONTRACTOR SHALL BE RESPONSIBLE FOR ESTABLISHING AND MAINTAINING EROSION AND SEDIMENT CONTROL DURING ALL STAGES OF CONSTRUCTION.
  - CONTRACTOR SHALL INSTALL PERIMETER EROSION AND SEDIMENT CONTROL MEASURES (E.G. SILT FENCE, HAY BALES) PRIOR TO INITIATING EARTH DISTURBING ACTIVITIES AS SHOWN ON THE DRAWINGS.
  - CONTRACTOR SHALL CONSTRUCT SEDIMENT BASIN AS SHOWN ON THE DRAWINGS PRIOR TO BUILDING LANDFILL PERIMETER CHANNELS.
  - CONTRACTOR SHALL DISTURB ONLY THOSE AREAS DESIGNATED ON THE DRAWINGS OR REQUIRED TO PERFORM THE CONSTRUCTION.
  - TRENCH EXCAVATION SHALL PROCEED SO AS TO MINIMIZE THE LENGTH OF OPEN TRENCH AT ANY ONE TIME. MATERIAL EXCAVATED FROM TRENCH SHALL BE PLACED ON HIGH SIDE OF TRENCH. ANY SHEETING/SHOULDER MEASURES SHALL ADHERE TO OSHA REQUIREMENTS.
  - ALL CHANNELS DESIGNATED TO RECEIVE RIP-RAP PROTECTION OR TO BE SEEDED AND MULCHED SHALL BE STABILIZED IMMEDIATELY UPON REACHING FINISHED GRADES. IF SEASON PROHIBITS PERMANENT SEEDING, PLACE TEMPORARY SEED AND/OR MULCH AND SOW PERMANENT SEED DURING NEXT GROWING SEASON.
  - OUTLET PROTECTION (I.E. STONE APRONS) SHALL BE INSTALLED IMMEDIATELY UPON COMPLETION OF CULVERT AND/OR CHANNEL CONSTRUCTION.
  - SHOULD CONDITIONS ARISE IN THE FIELD WHICH RENDER THE EROSION AND SEDIMENTATION CONTROLS FOR THIS PROJECT INAPPROPRIATE OR INADEQUATE THE CONTRACTOR SHALL IMMEDIATELY NOTIFY THE OWNER. ADDITIONAL DRAWINGS OR MODIFICATIONS, WHEN REQUIRED, WILL BE FURNISHED BY THE OWNER AND WILL BECOME PART AND A CONDITION OF THE EROSION AND SEDIMENTATION CONTROL PLAN UPON APPROVAL BY THE REVIEWING AGENCY.

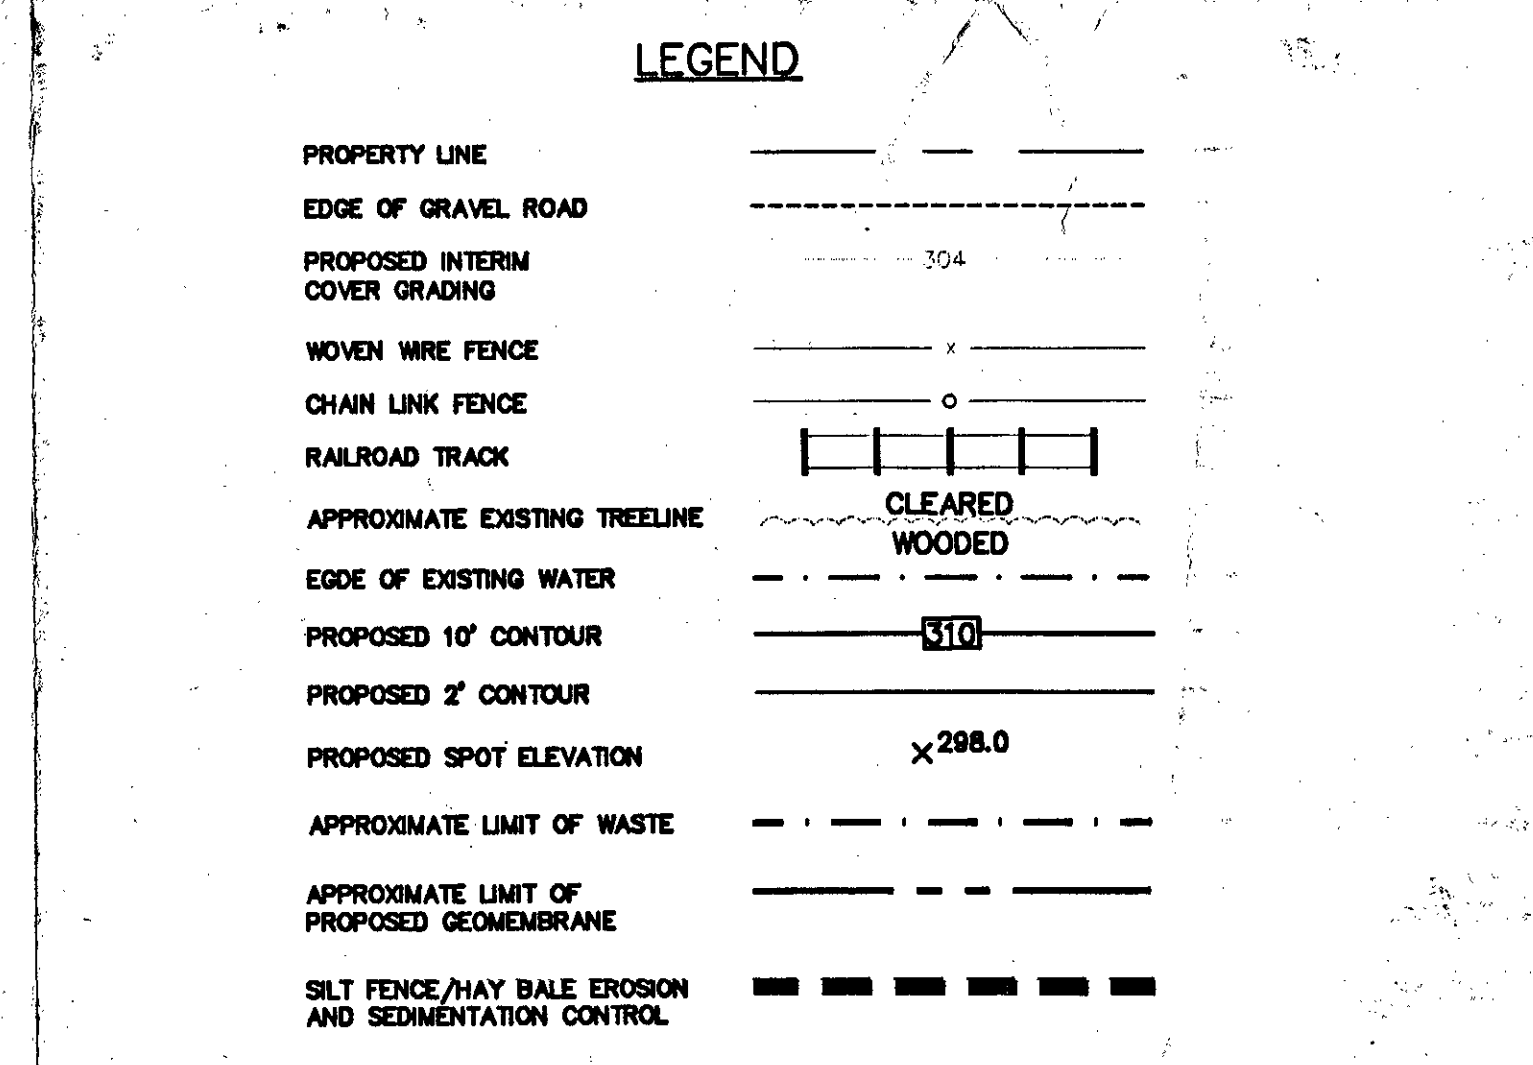

**BERNARDSTON LANDFILL CLOSURE**  
BERNARDSTON, MASSACHUSETTS

**PROPOSED GRADING PLAN**

PROJECT NO: OMNI\_005.DWG  
DRAWING No: C-2  
SHEET 2 OF 5

DATE: MAY 1999  
SCALE: AS SHOWN  
DESIGNED BY: DM  
DRAWN BY: DRM, FCM  
CHECKED BY: RMD  
APPROVED BY: [Signature]

FOSTER WHEELER ENVIRONMENTAL CORPORATION  
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433 West Street  
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(617) 256-0094

99-029-001

GRAPHIC SCALE  
1 inch = 40 ft.

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NO.	REVISION	DATE	APPROVED
1	ISSUED FOR INTERNAL REVIEW	5/20/99	[Signature]
2	REVISION SUBMITTED MANAGEMENT FEATURES	6/2/99	[Signature]
3	ISSUED FOR INTERNAL REVIEW	7/9/99	[Signature]
4	ISSUED FOR INTERNAL REVIEW	8/2/99	[Signature]

REVISIONS TO BE MADE BY: [Signature]

DESIGNED BY: DM  
DRAWN BY: DRM, FCM  
CHECKED BY: RMD  
APPROVED BY: [Signature]

DATE: MAY 1999  
SCALE: AS SHOWN  
DESIGNED BY: DM  
DRAWN BY: DRM, FCM  
CHECKED BY: RMD  
APPROVED BY: [Signature]

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**PROPOSED GRADING PLAN**

PROJECT NO: OMNI\_005.DWG  
DRAWING No: C-2  
SHEET 2 OF 5